




West Elevation  
1 : 100




North Elevation  
1 : 100




South Elevation  
1 : 100

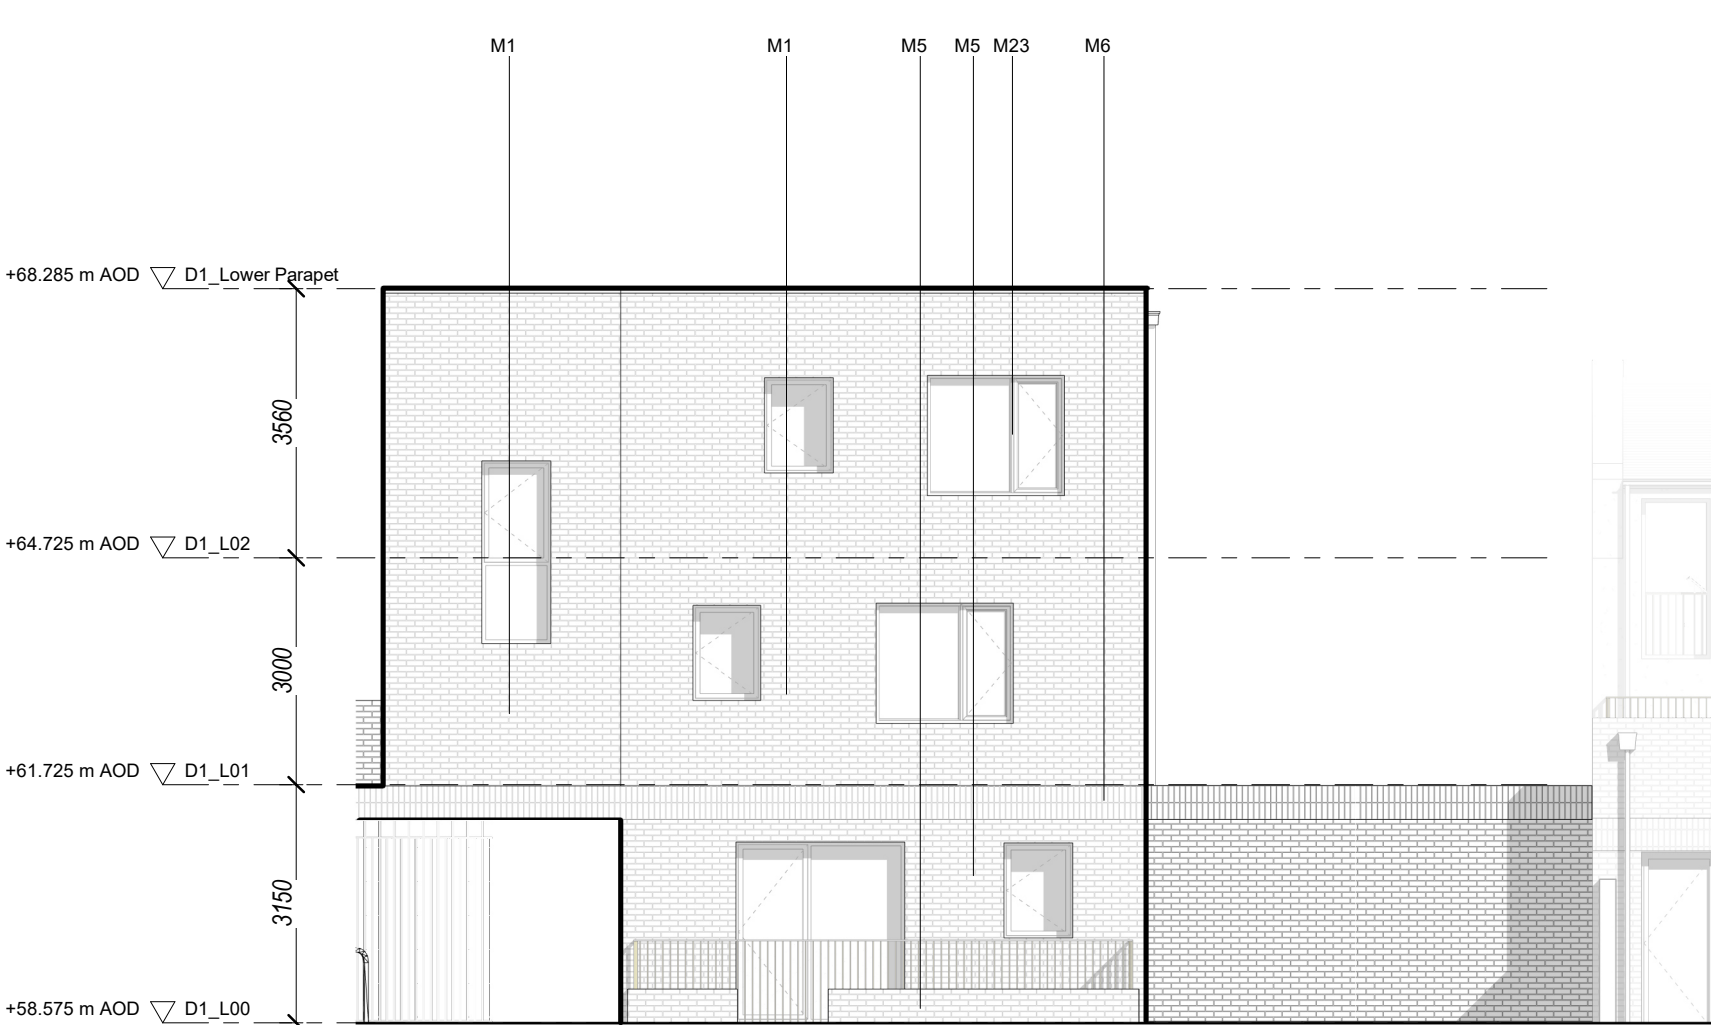

South Elevation - Rear  
1 : 100

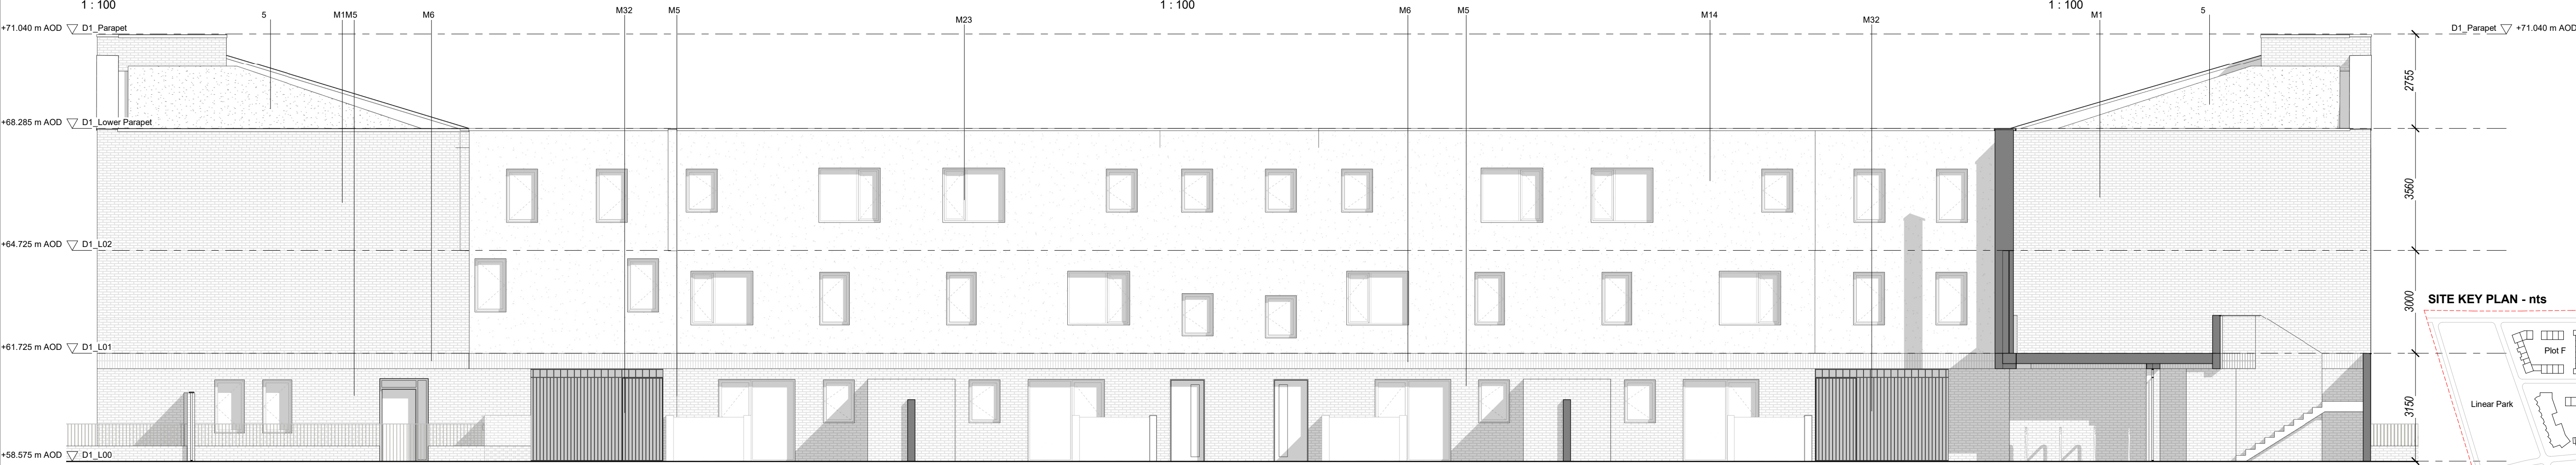

East Elevation - Rear  
1 : 100

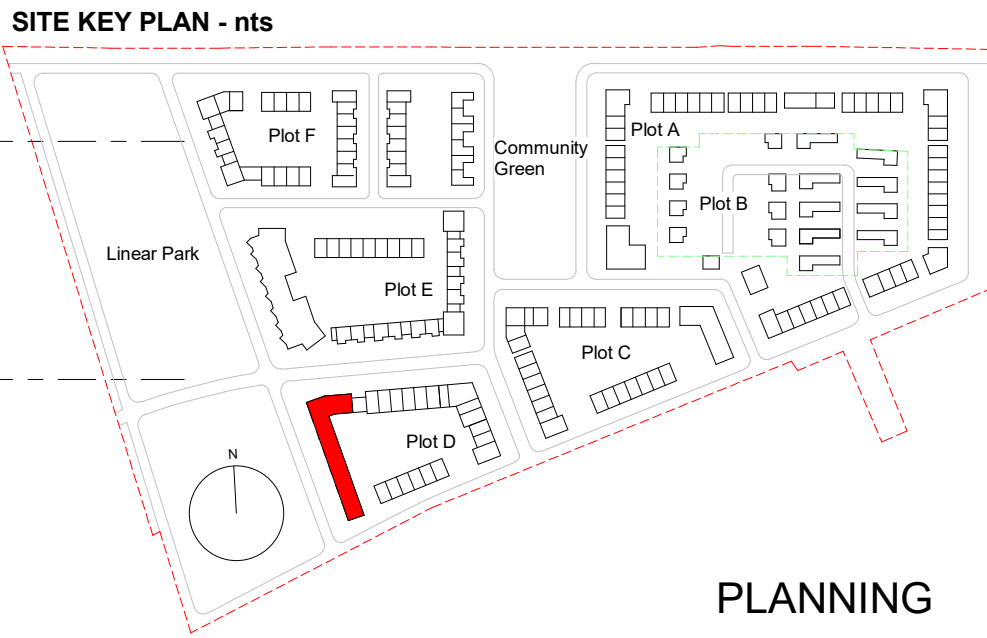

PLANNING

| Revision | Date       | Description                                | Issued | Checked |
|----------|------------|--------------------------------------------|--------|---------|
| P1       | 15.03.2022 | Issued for Pre-Part 8 Planning Application | OB     | SC      |
| P2       | 13.04.2022 | Issued for Part 8 Planning Application     |        | SC      |
|          |            |                                            |        |         |
|          |            |                                            |        |         |
|          |            |                                            |        |         |
|          |            |                                            |        |         |
|          |            |                                            |        |         |
|          |            |                                            |        |         |
|          |            |                                            |        |         |



Notes

Do not scale drawings. All dimensions should be checked on site. Errors to be reported to architect. To be read in conjunction with all relevant architects services and engineers drawings.

Contractors, sub-contractors and suppliers must verify any critical dimensions on site prior to fabrication of any building element. Any discrepancies are to be reported to the architect.


This drawing should be read in conjunction with all relevant specifications, engineers nd specialists consultants information. Any discrepancies must be reported prior to installation.

Materials Key

- 5 Green Roof
- 7 Roof Light
- M1 Red Brickwork - stretcher bond Colour TBC
- M2 Red Brickwork - stacked bond Colour TBC
- M3 Buff Brickwork - stretcher bond Colour TBC
- M4 Buff Brickwork - stacked bond Colour TBC
- M5 Brown Brickwork - stretcher bond Colour TBC
- M6 Brown Brickwork - stacked bond Colour TBC
- M13 Smooth Render - Colour TBC

- M14 Rough Render - Colour TBC
- M20 Insulated flat green roof (single-ply buildip) set to falls 3400mm high
- M21 Glazing
- M23 Aluminium / timber composite window frames, colour TBC
- M24 Solid Panel Door with glazed side panel and fanlight above
- M25 Solid Panel Door, Colour TBC
- M26 PPC Metal Rainwater goods, Colour TBC
- M30 PPC Metal Railing, Colour TBC
- M31 PPC Metal garden entrance gate, Colour TBC

- M32 PPC Metal Courtyard Entrance Gate and Railing, nom.
- M35 Perforated Brickwork
- M36 Solid panel door with fanlight above
- M37 Aluminium / timber composite glazed door, colour TBC

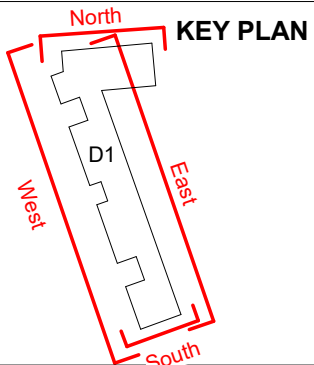

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Project: Clonburris Phase One  
Client: SDCC  
Location: Clonburris Co.Dublin  
Title: Block D1 Elevations  
Current Revision Issue Date: 13.04.2022  
Scale: 1 : 100 @ A1

| Drawing Number: | Project | Originator | Volume | Level | Type | Role | Reference | Suitability | Revision |
|-----------------|---------|------------|--------|-------|------|------|-----------|-------------|----------|
|                 | 2015    | MET        | D1     | XX    | DR   | A    | 112400    | S4          | P2       |